100% DESIGN

# SUTTER BUTTE FLOOD CONTROL AGENCY

PROJECT PLANS FOR CONSTRUCTION OF

# FEATHER RIVER WEST LEVEE PROJECT

UPRR CLOSURE STRUCTURE PLANS



CONTRACT NO.

APPROVED BY:\_ DATE: Michael W. Bessette. P.E. Director Of Engineering Sutter Butte Flood Control Agency

100% DESIGN

J:\Jobs\8455_F	DATE	BY	 APPR.	DESCRIPTION	REV.	DATE	-	0	APPR.	DESCRIPTION	J. CHAPMAN IN CHARGE: J. KORS DATE: 02/06/2015
HDR_Sutter											DRAWN BY: J. PATCHETT CHECKED BY:
a_Butte											DESIGNED BY: J. PATCHETT



SUBMITTED

JOOD RODGERS

APPROVED


FEATHER RIVER WEST LEVEE PROJECT UPRR CLOSURE STRUCTURE PLANS

SUTTER BUTTE FLOOD CONTROL AGENCY

TITLE SHEET AND LOCATION MAP

ORIGINAL DRAWING, ADJUST SCALES FOR REDUCED PLOTS

DRAWING NO. SHEET G-001

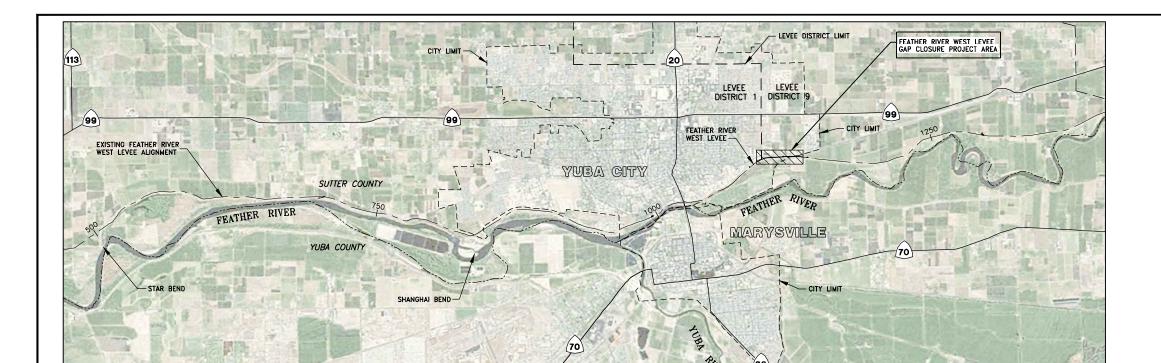


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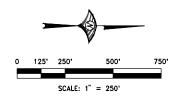
0 2000' 4000' 8000' 12000'

### SHEET INDEX

DRAWING	SHEET	
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C-505	10	LIPPR CLOSURE ASSEMBLY SEQUENCE AND NOTES





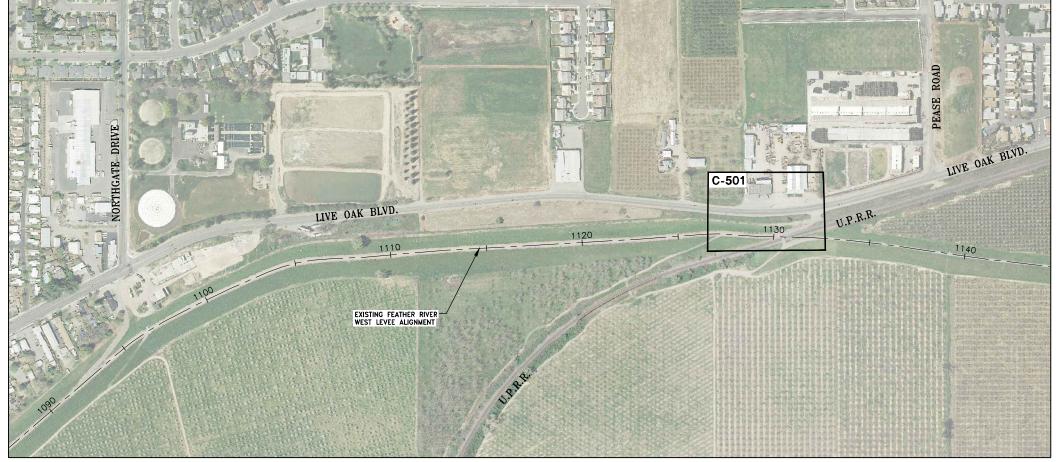

100% DESIGN

FCA\FRWL_TO											<b>KEY MAP</b> SCALE: 1" = 250'	
Butte												DESIGNED BY:  J. PATCHETT
												DRAWN BY:
Sutter												J. PATCHETT
												CHECKED BY: J. CHAPMAN
Jobs\8455_												IN CHARGE:
S Sq												J. KORS
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3501 C STREET, BLDG, 102-B, SAGRAMENTO, CA 99816
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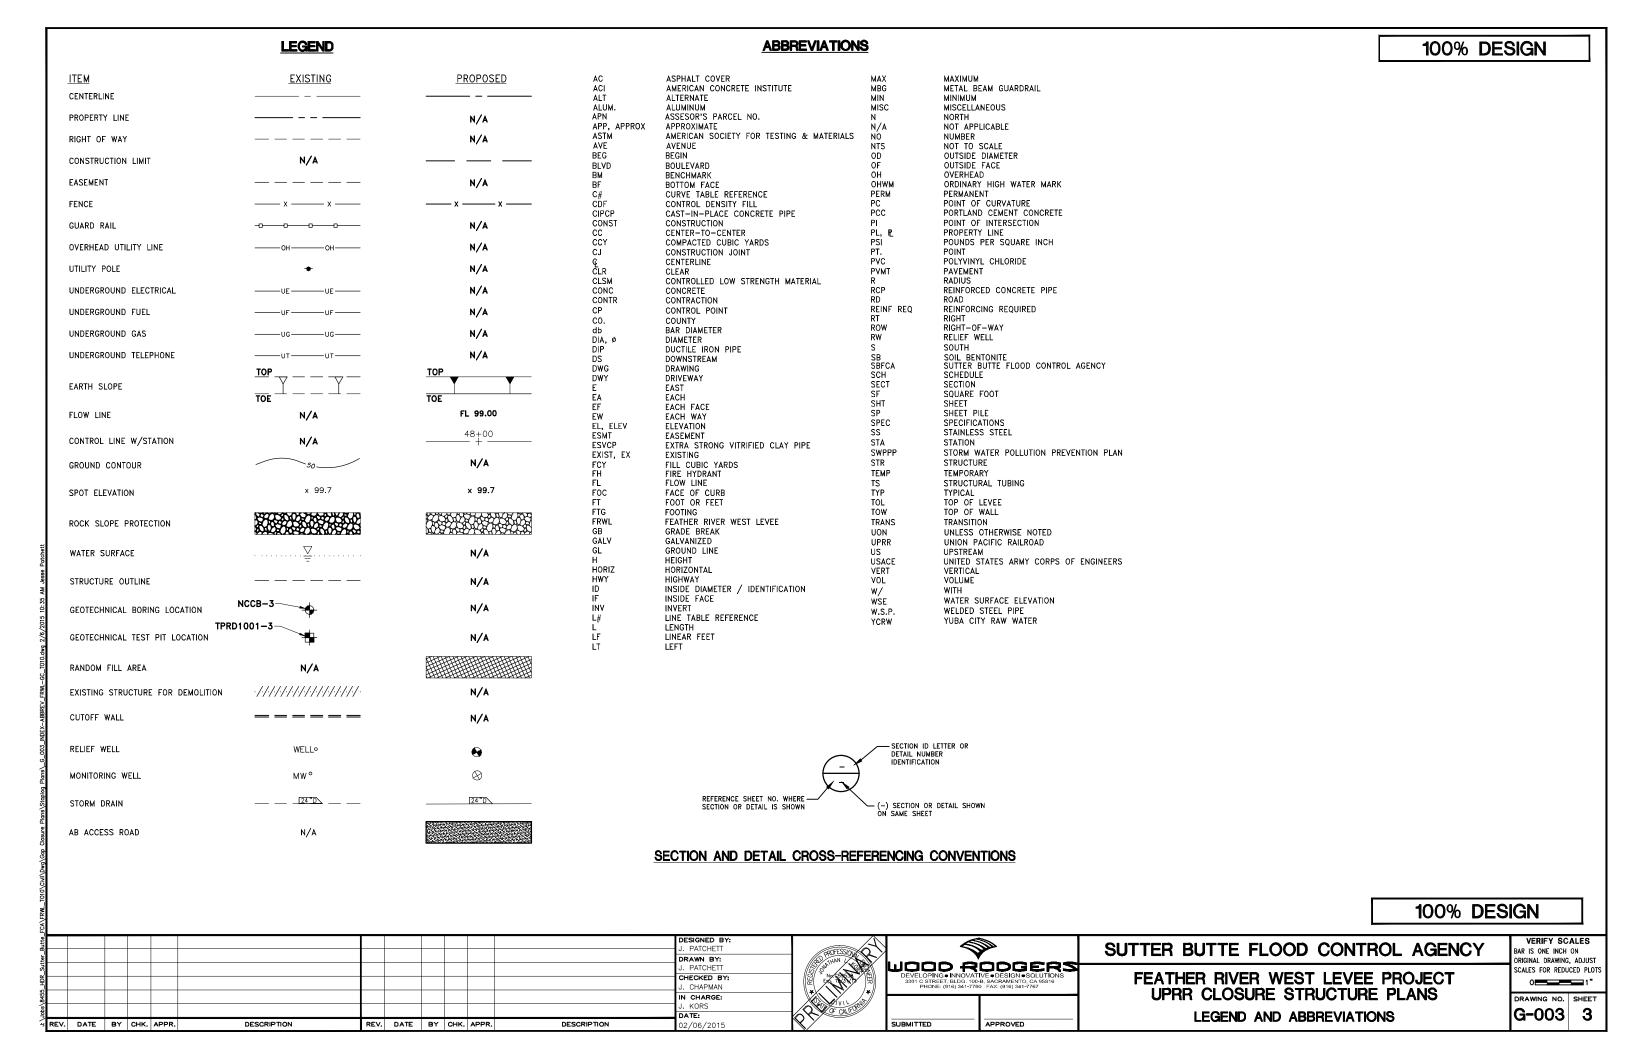
APPROVED

SUBMITTED

SUTTER BUTTE FLOOD CONTROL AGENCY

FEATHER RIVER WEST LEVEE PROJECT UPRR CLOSURE STRUCTURE PLANS VICINITY MAP, KEY MAP, & SHEET INDEX

G-002 2



### **GENERAL NOTES**

- THE CONTRACTOR SHALL COORDINATE WORK WITH THE APPROPRIATE UTILITY SERVICE PROVIDER WHEN WORKING NEAR POWER LINES, POWER POLES, GAS MAINS, OR ANY OTHER UTILITY STRUCTURES, BOXES, ETC..
- UTILITY INFORMATION WAS COMPILED FROM DATA PROVIDED BY THE UTILITY OWNERS AND LOCATIONS ARE APPROXIMATE. THE ACTUAL LOCATIONS AND ELEVATIONS OF THE EXISTING UTILITIES SHALL BE VERIFIED BY THE CONTRACTOR. ALL EXISTING UNDERGROUND AND OVERHEAD UTILITIES SHALL BE PROTECTED FROM CONSTRUCTION EQUIPMENT AND OPERATIONS.
- 3. THE CONTRACTOR IS HEREBY NOTIFIED THAT, PRIOR TO COMMENCING CONSTRUCTION, THE CONTRACTOR IS RESPONSIBLE FOR CONTACTING ALL UTILITY COMPANIES INVOLVED WITH THIS PROJECT. IN ADDITION, THE CONTRACTOR IS TO REQUEST TO HAVE ALL UNDERGROUND UTILITIES WHICH MAY POSSIBLY CONFLICT WITH THE ABOVEGROUND OR BELOWGROUND IMPROVEMENTS IDENTIFIED IN THE FIELD. THE CONTRACTOR OR ANY SUBCONTRACTOR IS REQUIRED TO NOTIFY UNDERGROUND SERVICE ALERT (U.S.A) 48 HOURS IN ADVANCE OF PERFORMING ANY EXCAVATION BY CALLING (800) 227-2600.
- 4. THE CONTRACTOR IS RESPONSIBLE FOR PROTECTING ALL UTILITIES DURING CONTRACT ACTIVITIES.
- 5. THE OPERATORS OF FACILITIES ON THE FRWL WILL REQUIRE A PLAN FOR OPERATION AND MAINTENANCE ACCESS. OPERATORS WILL BE INVITED TO WEEKLY CONSTRUCTION MEETINGS AND WILL REQUIRE NOTIFICATION FOR ACCESS ALONG THE LEVEE DURING CONSTRUCTION. THE WORK SHALL BE COORDINATED THROUGH THE AGENCY'S CONSTRUCTION MANAGER.
- 6. THE CONTRACTOR SHALL BE SOLELY AND COMPLETELY RESPONSIBLE FOR FURNISHING AND MAINTAINING ALL WARNING SIGNS, DEVICES, AND FEATURES NECESSARY TO PROTECT THE HEALTH AND SAFETY OF THE GENERAL PUBLIC AND WORKERS AND TO PROVIDE FOR THE PROPER AND SAFE ROUTING OF VEHICULAR AND PEDESTRIAN TRAFFIC DURING THE PERFORMANCE OF THE WORK.
- THE CONTRACTOR SHALL BE RESPONSIBLE FOR COMPLIANCE WITH ALL APPLICABLE FEDERAL, STATE, AND LOCAL LAWS, RULES, AND REGULATIONS APPLICABLE TO ALL WORK PERFORMED UNDER THE CONTRACT.
- 8. THE CONTRACTOR SHALL VERIFY ALL DIMENSIONS, SIZES, AND LOCATIONS OF ALL EXISTING FACILITIES AND FEATURES BEFORE STARTING WORK AND SHALL IMMEDIATELY NOTIFY THE ENGINEER OF ANY DISCREPANCIES.
- 9. ALL CONSTRUCTION MATERIALS SHALL CONFORM TO THE CONTRACT SPECIFICATIONS.
- 10. THE CONTRACTOR SHALL BE IN RECEIPT OF AGENCY-APPROVED PLANS PRIOR TO BEGINNING CONSTRUCTION WITHIN ANY AGENCY RIGHT-OF-WAY.
- 11. THE CONTRACTOR IS RESPONSIBLE FOR PROTECTING ALL EXISTING MONUMENTS AND OTHER SURVEY MARKERS. MONUMENTS AND SURVEY MARKERS DESTROYED DURING CONSTRUCTION SHALL BE REPLACED BY A LICENSED LAND SURVEYOR AT THE CONTRACTOR'S EXPENSE.
- 12. THE CONTRACTOR SHALL BE RESPONSIBLE FOR MAINTAINING RECORD DRAWINGS FOR ALL WORK THROUGHOUT THE COURSE OF CONSTRUCTION. SUCH DRAWINGS SHALL RECORD THE LOCATION AND GRADE OF ALL IMPROVEMENTS AND FILLS THAT ARE CONSTRUCTED AND COPIES SHALL BE DELIVERED TO THE AGENCY PRIOR TO THE ACCEPTANCE OF THE WORK AS INDICATED IN THE SPECIFICATIONS.
- 13. DRAWINGS SHOWN WITH AERIAL PHOTOGRAPHS ARE PROVIDED FOR REFERENCE ONLY. ALL FACILITIES MAY NOT BE SHOWN ON PHOTOGRAPHS. THE CONTRACTOR SHALL SATISFY ITSELF AS TO THE LOCATION OF EXISTING FACILITIES THAT MAY BE AFFECTED BY CONSTRUCTION
- 14. EXISTING FENCING AND GATES WITHIN THE RIGHT-OF-WAY SHALL BE REMOVED AS REQUIRED FOR CONSTRUCTION AND AS SPECIFIED ON THE PLANS. SALVAGE OF FENCING ITEMS SHALL BE IN ACCORDANCE WITH THE SPECIFICATIONS. WHERE EXISTING FENCING OR BARRIERS ARE REMOVED, TEMPORARY BARRIERS SHALL BE PROVIDED. FENCING AND GATE SIGNS SHALL BE REPLACED FOLLOWING CONSTRUCTION OF THE CUTOFF WALL AND CONSTRUCTION OF THE LEVEE EMBANKMENT.
- 15. SEE SPECIFICATION SECTION 01 35 26, GENERAL SIGNAGE AND SAFETY REQUIREMENTS, REGARDING PROJECT-RELATED SIGNS TO BE FURNISHED AND INSTALLED BY THE CONTRACTOR
- 16. THE CONTRACTOR SHALL PROVIDE EROSION AND SEDIMENT CONTROL IN ACCORDANCE WITH THE STORM WATER POLLUTION PREVENTION PLAN.
- 17. THE CONTRACTOR SHALL PROVIDE DUST CONTROL AND STREET CLEANING MEASURES AT ALL TIMES AS INDICATED IN THE SWPPP DOCUMENT.
- ADMINISTRATION OF ALL WORK BY THE CONTRACTOR SHALL COMPLY WITH THE GENERAL SPECIFICATIONS.
- 19. THE CONTRACTOR IS SOLELY RESPONSIBLE FOR VERIFYING THE ADEQUACY OF EXISTING BRIDGE CROSSINGS PRIOR TO UTILIZING FOR ACCESS TO THE SITE OR FOR ANY HAULING ACTIVITIES. CROSSINGS DAMAGED AS A RESULT OF CONSTRUCTION ACTIVITIES SHALL BE IMMEDIATELY RESTORED TO PRECONSTRUCTION CONDITION BY THE CONTRACTOR AT NO COST TO THE AGENCY. NOT ALL BRIDGE CROSSINGS ARE SHOWN ON THESE PLANS.

### BASIS OF DESIGN

- 1. GEOTECHNICAL INFORMATION USED FOR THIS DRAWING SET WAS PROVIDED BY URS, INC. IN THE FOLLOWING MEMORANDIM:
  - A. RELIEF WELL DESIGN FOR UPRR AT THE FEATHER RIVER WEST LEVEE, DATED MARCH 2014
- 2. THE DESIGN WATER SURFACE ELEVATIONS WERE PROVIDED BY PBI, INC. IN THE FOLLOWING MEMORANDUM:
  - A. DESIGN WATER SURFACE PROFILES FOR THE FEATHER RIVER WEST LEVEE REHABILITATION PROJECT, DATED JULY 2012.
- 3. THE PERFORMANCE OF LEVEE SYSTEMS IS DEPENDENT UPON THE DESIGN CRITERIA AND THE LONG TERM OPERATION AND MAINTENANCE OF THE LEVEES. WOOD RODGERS, INC. HAS PREPARED THESE PLANS AND ASSOCIATED SPECIFICATIONS IN ACCORDANCE WITH GENERALLY ACCEPTED ENGINEERING PRACTICE USING INFORMATION FROM MULTIPLE SOURCES, INCLUDING SBFCA'S OTHER DESIGN CONSULTANTS. IF EXTREME FLOODS (EXCEEDING THE DESIGN PROFILE), EARTHQUAKES, OR OTHER LOADING CONDITIONS NOT EVALUATED IN THE DESIGN OCCUR, THE INTEGRITY OF THE LEVEE SYSTEM MAY BE COMPROMISED.

### SWPPP

THE CONTRACTOR SHALL IMPLEMENT THE STORM WATER POLLUTION PREVENTION PLAN (SWPPP) IN ACCORDANCE WITH THE PROJECT SPECIFICATIONS. THE SWPPP WAS PREPARED AND PROVIDED BY ICF, INC.

#### PERMIT NOTES

A PERMIT FROM THE CENTRAL VALLEY FLOOD PROTECTION BOARD WILL BE OBTAINED IN ORDER TO CONSTRUCT THE IMPROVEMENTS AS SHOWN ON THE PLANS. A COPY OF THE PERMIT WILL BE AVAILABLE TO THE CONTRACTOR DURING THE BIDDING PROCESS IF IT IS AVAILABLE, OTHERWISE A COPY OF THE PROJECT C (CONTRACT NO. 01-2013C) PERMIT WILL BE MADE AVAILABLE AS A SAMPLE. THE CONTRACTOR SHALL FOLLOW ALL CONDITIONS AS INDICATED IN THIS PERMIT. A COPY OF THIS PERMIT SHALL BE POSTED ON THE CONSTRUCTION SITE. SEE GENERAL SPECIFICATIONS AND SPECIAL PROVISIONS FOR PERMITS APPLICABLE TO THE CONTRACT.

### **UPRR COORDINATION NOTES**

- 1. UPRR HAS APPROVED THE STOPLOG DESIGN SHOWN ON THESE DRAWINGS.
- 2. CONTACT PEGGY BUHAY WITH UPRR AT 916-789-5152 PRIOR TO ANY WORK WITHIN THE CONSTRUCTION CLEARANCE ENVELOP SHOWN ON C-505.
- 3. ALL EQUIPMENT AND MATERIAL SHALL BE CLEARED FROM THE CONSTRUCTION CLEARANCE ENVELOPE BEFORE TRAINS PASS.
- 3. CONSTRUCTION SEQUENCING IS CRITICAL FOR THIS PROJECT DUE TO THE PROXIMITY OF TRACK AND POSSIBLE SERVICE INTERRUPTION. THEREFORE, THE CONTRACTOR MUST SUBMIT A DETAILED WORK PLAN TO UPRR FOR REVIEW AND APPROVAL. A SUGGESTED WORK PLAN PROVIDED BY UPRR CONSIDERING A MAXIMUM WORK WINDOW OF 2 HOLIES IS SHOWN RELOW.
- STEP 1 INSTALL SHORING (OR SHEET PILING, ETC.) FOR CONSTRUCTION OF CONCRETE RETAINING WALL. SHORING PLANS AND CALCULATIONS SHALL BE SUBMITTED TO UPRR FOR REVIEW AND APPROVAL. IT IS ANTICIPATED SHORING CAN BE INSTALLED UNDER FORM B WITH FLAGMAN PROTECTION.
- STEP 2 INSTALL PIER CASING. IT IS ANTICIPATED THAT CASING CAN BE INSTALLED UNDER FORM B WITH FLAGMAN PROTECTION. CONTRACTOR SHALL PROVIDE ANTICIPATED DRIVING TIME (LESS THAN 2 HOURS) AND SHALL COORDINATE OPERATIONS WITH THE RAILROAD WITHIN AVAILABLE TRACK WINDOWS. CASING SHALL BE DRIVEN TO BASE OF RAIL ELEVATION OR LOWER.
- STEP 3 EXCAVATION OF PIERS WITHIN CASING (IF HOLLOW CASING IS NOT USED), PLACEMENT OF STEEL REINFORCING, PLACEMENT OF POST SOCKETS. IT IS ANTICIPATED THAT THESE ACTIVITIES CAN BE COMPLETED UNDER FORM B FLAGMAN PROTECTION.
- STEP 4 INSTALLATION OF STEEL SILL PLATES AND ATTACHMENT TO PILE CASINGS.
  THIS STEP WILL REQUIRE AN ABSOLUTE TRACK CLOSURE. CONTRACTOR SHALL PROVIDE METHOD OF SILL PLATE
  INSTALLATION AND ANTICIPATED WORKING TIME TO UPRR (LESS THAN 2 HOURS) FOR REVIEW AND APPROVAL AND
  SHALL COORDINATE OPERATIONS WITH THE RAILROAD WITHIN AVAILABLE TRACK WINDOWS.
- STEP 5 EXCAVATE AND FORM AT RETAINING WALLS. IT IS ANTICIPATED THESE ACTIVITIES CAN BE COMPLETED UNDER FORM B FLAGMAN PROTECTION.
- STEP 6 POUR PIERS. T IS ANTICIPATED THESE ACTIVITIES CAN BE COMPLETED UNDER FORM B FLAGMAN PROTECTION.
- STEP 7 INSTALL SILL HARDWARE. THIS STEP WILL REQUIRE AN ABSOLUTE TRACK CLOSURE. CONTRACTOR SHALL PROVIDE METHOD OF SILL PLATE INSTALLATION AND ANTICIPATED WORKING TIME TO UPRR (LESS THAN 2 HOURS) FOR REVIEW AND APPROVAL AND SHALL COORDINATE OPERATIONS WITH THE RAILROAD WITHIN AVAILABLE TRACK WINDOWS.
- STEP 8 PLACE STOPLOG PANELS AND CHECK ALIGNMENT. THIS STEP WILL REQUIRE AN ABSOLUTE TRACK CLOSURE. CONTRACTOR SHALL PROVIDE METHOD OF SILL PLATE INSTALLATION AND ANTICIPATED WORKING TIME TO UPRR (LESS THAN 2 HOURS) FOR REVIEW AND APPROVAL AND SHALL COORDINATE OPERATIONS WITH THE RAILROAD WITHIN AVAILABLE TRACK WINDOWS.

### ELECTRICAL WORK AND PEIZOMETER NOTES

- E1. THE DIVISION OF WORK BETWEEN THE ELECTRICAL SUBCONTRACTOR AND THE DRILLING SUBCONTRACTOR SHALL BE 3-FEET BELOW GROUND SURFACE. ALL WORK ABOVE THIS DIVISION SHALL BE THE RESPONSIBILITY OF THE ELECTRICAL CONTRACTOR UNLESS OTHERWISE NOTED ON THE PLANS.
- E2. PVC CONDUIT SIZES AND TRENCH DIMENSIONS SHALL BE CONSTRUCTED AS SHOWN ON DWG C-301 AND C-304.
- E3. PRIOR TO COMMENCEMENT OF WORK, SUBCONTRACTOR SHALL HAVE ALL EQUIPMENT NECESSARY FOR COMPACTION OF TRENCHES AT SITE IN WORKING CONDITION.
- E4. TRENCH EXCAVATION SHALL BE BACKFILLED AND COMPACTED IN MAXIMUM 6-INCH LOOSE LIFTS TO AT LEAST 95% COMPACTION. BACKFILL SHALL BE MOISTURE CONDITIONED TO AT LEAST ONE PERCENTAGE POINT ABOVE THE OPTIMUM WATER CONTENT. COMPACTION OF THE FIRST LIFT OF MATERIAL NEEDS TO BE PERFORMED SO THAT THE PVC CONDUIT IS NOT DAMAGED. MECHANICAL TAMPING EQUIPMENT OR OTHER APPROVED METHOD WILL BE USED AS NEEDED OR DIRECTED BY THE ENGINEER.
- E5. NATIVE BACKFILL MATERIAL SHALL CONSIST OF NATIVE SOIL, FREE OF ORGANICS ROCKS, STONES, AND SOLID EARTH CHUNKS EXCEEDING TWO INCHES. ALL OTHER UNSUITABLE MATERIAL SHALL BE REMOVED AS DIRECTED BY THE FNGINFFR
- E6. NORMAL CONCRETE SHALL CONSIST OF QUIKCRETE CONCRETE MIX (NO.1101), OR APPROVED EQUIVALENT, PREPARED AND PLACED IN ACCORDANCE WITH THE MANUFACTURER'S INSTRUCTIONS.
- E7. COPPER GROUNDING WIRE SHALL CONFORM TO AWG 8 AND HAVE A METALLIZED MYLAR RIBBON WRAPPED AROUND IT ALLOWING THE CONDUITS TO BE TRACED IN THE FUTURE.
- E8. PVC ELBOWS FOR CONDUITS SHALL BE A MINIMUM ONE FOOT RADIUS OR AS APPROVED BY ENGINEER.
- THE INTERIOR OF THE HAND HOLE INSTALLATIONS SHALL BE SLOPED TO DRAIN TOWARDS THE 3/8-INCH PVC DRAIN PIPE. DUCT SEAL SHALL BE USED ON ALL OPEN CONDUIT ENDS.
- E10. ENGINEER AND SUBCONTRACTOR SHALL EXAMINE ALL MATERIALS PRIOR TO INSTALLATION. DEFECTIVE OR DAMAGED MATERIAL SHALL NOT BE USED AND SHALL BE REPLACED AT CONTRACTOR'S EXPENSE.
- E11. ALL EXCESS PRODUCTS INCLUDING, BUT NOT LIMITED TO CONCRETE AND PVC MATERIALS, SHALL BE REMOVED FROM THE PROJECT SITE BY CONTRACTOR AT THE TIME OF COMPLETION OF THE PROJECT.
- E12. ANY DAMAGE CAUSED TO THE LEVEE OR SURROUNDING AREA AS A RESULT OF SUBCONTRACTOR'S WORK SHALL BE REPAIRED PRIOR TO DEMOBILIZATION AT NO ADDITIONAL COST TO THE OWNER.
- E13. LEADS FROM EACH TRANSDUCER SHALL BE TAGGED WITH A STAMPED BRASS DISC WITH THE PIEZOMETER NUMBER AT EACH VAULT AND AT THE DATA LOGGER.

### PG&E GAS PIPE NOTES

- 1. UNDERGROUND SERVICE ALERT (U.S.A.) SHALL BE NOTIFIED AT LEAST TWO DAYS BEFORE EXCAVATION OR CONSTRUCTION BEGINS, (800) 227-2600. CONTRACTOR SHALL REQUEST A FIELD MEETING WITH A PG&E LOCATOR (VIA U.S.A. COMMENT SECTION) TO DISCUSS THE PROPOSED WORK AND CONFIRM PG&E CONTACT INFORMATION.
- 2. A PG&E STANDBY PERSON IS REQUIRED TO BE ON SITE WHENEVER EXCAVATION IS WITHIN 5 FEET OF THE EDGE OF A GAS PIPE (PIPELINE PROTECTION ZONE) OR GAS PIPE APPURTENANCES. CONTRACTOR SHALL CALL PG&E AT (916) 386-5153, 48-HOURS IN ADVANCE OF THE WORK TO REQUEST AN INSPECTOR FOR STANDBY.
- 3. PRIOR TO USING ANY POWER-OPERATED EQUIPMENT, THE APPROXIMATE LOCATION OF THE PIPE MUST FIRST BE DETERMINED BY HAND EXCAVATION OR CAREFUL PROBING. PROBE AT RIGHT ANGLES TO THE PIPE AT A DEPTH OF 24 INCHES AND AT SPACING NO GREATER THAN 5 INCHES. IF IT IS DETERMINED THAT THE DEPTH OF THE PIPE IS GREATER THAN THE INITIAL PROBING OR HAND EXCAVATION, THEN EXCAVATION BY POWER-OPERATED EQUIPMENT WILL BE PERMITTED TO A DEPTH 12 INCHES LESS THAN THE ACTUAL PROBING OR HAND DUG DEPTH. HAND DIGGING IS REQUIRED WITHIN 12 INCHES OF THE PIPE. PG&E STANDBY MUST BE PRESENT.
- 4. PRIOR TO CROSSING EQUIPMENT OVER ANY GAS PIPE, THE CONTRACTOR SHALL VERIFY THE LOCATION AND DEPTH OF THE EXISTING GAS PIPE. IF THE DEPTH OF THE EXISTING GAS PIPE IS NOT ADEQUATE TO PROVIDE THE REQUIRED WHEEL LOADING BASED ON DISCUSSIONS WITH PG&E, THE CONTRACTOR SHALL COORDINATE WITH PG&E ON AN ACCEPTABLE METHOD TO PROTECT THE PIPE PRIOR TO CROSSING.

CONTACT REPRESENTATIVES							
CLIENT / CONSULTANT		REPRESENTATIVES	PHONE				
UNDERGROUND ALERT	U.S.A.		800-227-2600				
OWNER	SBFCA	MICHAEL BESSETTE	530-755-9869				
OWNER (O&M)	LEVEE DISTRICT NO. 1	BILL HAMPTON	530-673-2454				
UNION PACIFIC RAILROAD	_	PEGGY BUHAY	916-789-5152				
DESIGN ENGINEER	WOOD RODGERS, INC.	JONATHAN KORS	916-326-5294				
FUEL	KINDER MORGAN	GREGG LIES	503-220-1239				
GEOTECHNICAL ENGINEER	URS	MICHAEL HUGHES	916-679-2000				
FIBER OPTIC	CENTURY LINK	BRETT HANKINS	916-788-1041				
SURVEYOR	WOOD RODGERS, INC.	MIKE LONG	916-326-5894				
GAS	PG&E	DARRELL DAVIS	925-244-3791				
ELECTRICITY - DISTRIBUTION	PG&E	JOSH HINKEY	916-408-3234				
ELECTRICITY - TRANSMISSION	PG&E	JOSH HINKEY	916-408-3234				
TELEPHONE	AT&T	GREG ELLIS	916-409-1355				
CABLE	COMCAST	BRANDON STOKES	530-332-5993				
PUBLIC WORKS	COUNTY OF SUTTER	AL SAWYER	530-822-7450				
PUBLIC WORKS	CITY OF YUBA CITY	DIANA LANGLEY	530-822-4632				
WATER	CITY OF YUBA CITY	SHARON LYDON	530-822-4632				
D DUITTE EL 60	D CONTROL	4.0511017	VERIFY SCALES				

# SUTTER BUTTE FLOOD CONTROL AGENCY

FEATHER RIVER WEST LEVEE PROJECT UPRR CLOSURE STRUCTURE PLANS

**GENERAL NOTES** 

ORIGINAL DRAWING, ADJUST
SCALES FOR REDUCED PLOTS

O 1"

DRAWING NO. SHEET

BAR IS ONE INCH ON

JRE PLANS

DRAWING NO.

G-004

J. PATCHETT

DRAWN BY:
J. PATCHETT

CHECKED BY:
J. CHAPMAN

IN CHARGE:
J. KORS

DATE:
DATE:
DESCRIPTION

REV. DATE BY CHK. APPR. DESCRIPTION

0.06/2015

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APPROVED

UBMITTED



### SURVEY CONTROL POINTS

CP-474

1. THE FOLLOWING CONTROL POINTS HAVE BEEN ESTABLISHED BY WOOD RODGERS, INC. AS PART OF THE DEPARTMENT OF WATER RESOURCES (DWP) CENTRAL VALLEY FLOODPLAIN EVALUATION AND DELINEATION (CYFED) PROGRAM'S GLOBAL POSITIONING SYSTEM (GPS) CONTROL NETWORK AND ARE PROVIDED FOR THE CONTRACTOR'S USE:

POINT	NORTHING	EASTING	ELEV	C.S.F.	DESCRIPTION
451	2177143.772	6685135.676	68.733	1.000083577	5/8 REBAR W/CAP - WRC451
474	2199365.026	6657402.408	67.395	1.000081947	MAG NAIL/W WASHER - WRC474

- 2. THE CONTRACTOR SHALL PRESERVE AND PROTECT ALL CONTROL POINTS.
- CONTROL POINTS DISTURBED BY CONTRACTOR'S OPERATIONS SHALL BE REPLACED AT THE CONTRACTOR'S EXPENSE.

### LEGEND AND ABBREVIATIONS

C.F.S. COMBINED SCALE FACTOR

### NOTES:

- SURVEY DATA (AERIAL PHOTO, TOPOGRAPHIC MAPPING, BOUNDARY SURVEY, AND SURVEY CONTROL) SHOWN HEREON IS BASED ON INFORMATION PROVIDED BY: WOOD RODGERS, INC. THE AERIAL PHOTO IS DATED MARCH 16-17, 2008. THE SURVEY CONTROL WAS
- 2 TOPOGRAPHIC MAPPING IS BASED ON LIGHT DETECTION AND RANGING (LIDAR) DATA DATED MARCH 16-27, 2008, UNLESS OTHERWISE NOTED.
- BASELINE COORDINATES, DISTANCE, AND STATIONING SHOWN ON THE PLANS ARE "GRID" BASED UPON THE GLOBAL POSITIONING SYSTEM (GPS) CONTROL NETWORK, ADJUSTED TO NATIONAL GEODETIC SURVEY (NGS) PUBLISHED UTM ZONE 10 COORDINATES AND ORTHOMETRIC HEIGHT, CONVERTED TO CALIFORNIA COORDINATE SYSTEM, ZONE 2. MULTIPLY GRID DISTANCES WITH THE COMBINED SCALE FACTOR AS FOLLOWS TO OBTAIN GROUND DISTANCES:

STATION	C.S.F.		
800+00-1100+00	1.0000844943		
1100+00-1410+00	1.0000827419		

### HORIZONTAL DATUM

THE HORIZONTAL DAUTM OF THIS SURVEY IS THE NORTH AMERICAN DATUM OF 1983 (NAD83) BEING THE CALIFORNIA COORDINATE SYSTEM OF 1983 ZONE 2 (GRID SURFACE).

### **VERTICAL DATUM**

THE VERTICAL DATUM OF THIS SURVEY IS THE NORTH AMERICAN VERTICAL DATUM OF 1988 (NAVD88) BEING BASED ON NATIONAL GEODETIC SURVEY (NGS) POINTS LISTED AND DERIVED BY GLOBAL POSITIONING SYSTEM (GPS) STATIC METHOD.

100% DESIGN

DESIGNED BY:

J. PATCHETT

DRAWN BY:

J. PATCHETT

DRAWN BY:

J. PATCHETT

CHECKED BY:

J. CHAPMAN

IN CHARGE:

J. KORS

DATE:

SREV. DATE BY CHK. APPR. DESCRIPTION

DESCRIPTION

02/06/2015

△ CP-451

MARYSVILLE

LIVE OAK BLVD

FEATHER RIVER

YUBA CITY



LIVE OAK BLVD

APPROXIMATE LIMITS OF PROJECT WORK

STATE ROUTE 99

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3301 C STREET, BLDG, LOOG, SACRAMENTO, CA 99816
PHONE: (916) 341-7760 FAX: (916) 341-7767

1220


## SUTTER BUTTE FLOOD CONTROL AGENCY

FEATHER RIVER WEST LEVEE PROJECT UPRR CLOSURE STRUCTURE PLANS
SURVEY CONTROL MAP

VERIFY SCALES
BAR IS ONE INCH ON
ORIGINAL DRAWING, ADJUST
SCALES FOR REDUCED PLOT:

O 7

G-005 5

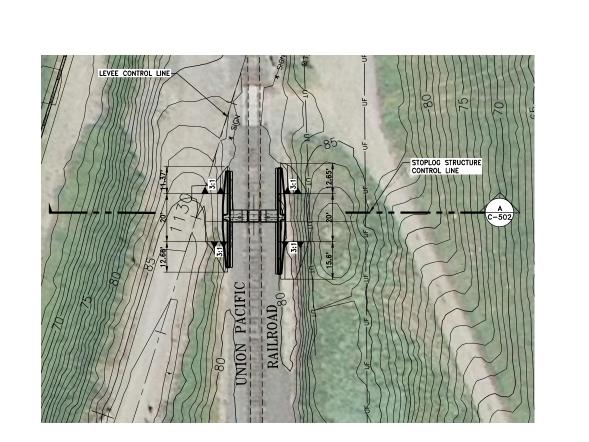

### CONSTRUCTION NOTES:

- 1 ALL WORK SHALL BE IN ACCORDANCE WITH THE U.P.R.R. PERMIT AND COORDINATED WITH THE U.P.R.R.
- 2 SEE SHEET G-102 FOR CONSTRUCTION ACCESS ROUTE

UPRR CLOSURE STRUCTURE PLANS

CLOSURE STRUCTURE PLAN & PROFILE @ UPRR CROSSING

3 CONTRACTOR SHALL INSTALL STOPLOG STRUCTURE FOLLOWING PER DETAILS ON DWGS C-502, C-503, C-504, AND C-505

100% DESIGN

HORIZ SCALE: 1" = 20'

VERT SCALE: 1" = 4"

C-501 6

- 4 LEVEE EMBANKMENT FILL (SOIL TYPE 1 AND 2) TO BE PLACED AND COMPACTED AS SHOWN IN DETAIL 7 ON DWG C-505 AND AS SPECIFIED IN SECTION 31 00 00 OF THE PROJECT SPECIFICATIONS.
- 5 SECTION VIEW IS SCHEMATIC. REFER TO DWG C-502, C-503, C-504, & C-505 FOR LINES, GRADES, AND CONSTRUCTION DETAILS.
- 6 RETAINING WALL AND FOOTING. SEE DETAIL C, DWG. C-503 FOR DETAILS.

## CLOSURE STRUCTURE PLAN (STA 1130+07.22)

IN CHARGE: J. KORS

02/06/2015


DATE:


DESCRIPTION

REV. DATE BY CHK. APPR.

DESCRIPTION

REV. DATE BY CHK. APPR.

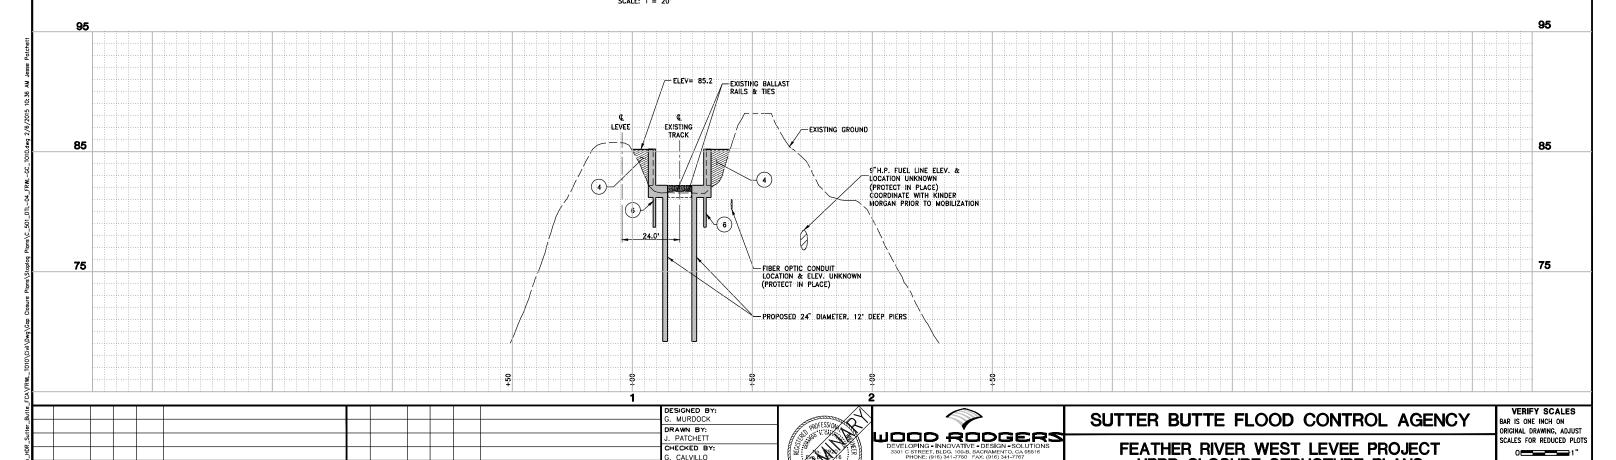

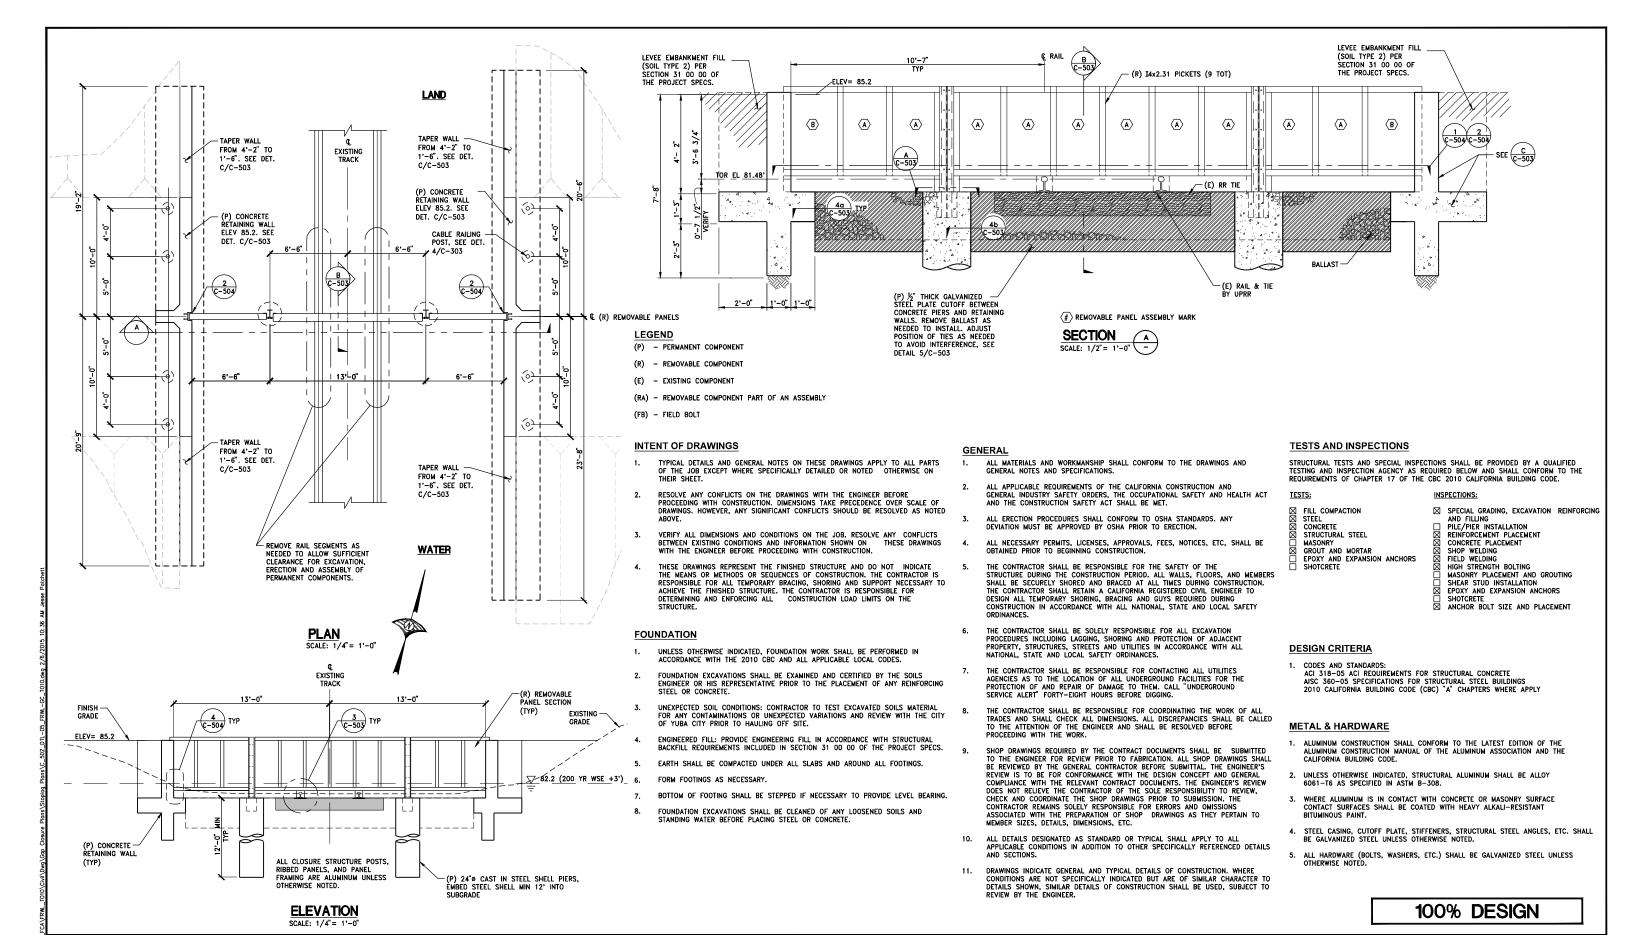

JOOD RODGERS

SUBMITTED

MURDOCK

DRAWN BY

CHECKED B CALVILLO

N CHARGE:

KORS

02/06/2015

DATE:

DESCRIPTION

REV. DATE BY CHK. APPR.

DESCRIPTION

REV. DATE BY CHK. APPR

SUTTER BUTTE FLOOD CONTROL AGENCY

FEATHER RIVER WEST LEVEE PROJECT UPRR CLOSURE STRUCTURE PLANS

SCALES FOR REDUCED PLOT

OCITICA 1"

DRAWING NO. SHEET

C-502

7

IAR IS ONE INCH ON

**VERIFY SCALES** 

UPRR CLOSURE STRUCTURE DETAILS (1 OF 3)

